

# NOTICE OF PROPOSED DEVELOPMENT

Notice is hereby given that an application has been made for planning approval under the Land Use Planning and Approvals Act 1993, for the following development(s):

NUMBER:	DA 59 / 2025
ADDRESS:	146 Sloping Main Dr, Sloping Main (CT: 89648/2)
DESCRIPTION:	Residential – Alterations and additions to a Dwelling
	(Retrospective)

All plans and documents submitted with the application can be inspected at the Tasman Council Office, Monday to Friday from 8:30am to 4:30pm. In addition to the statutory requirements, some documents, relevant to the assessment of the application are available on the council website by following this link:

https://tasman.tas.gov.au/advertised-applications/, by using the QR Code below, or they are available in hard copy upon request by calling Council on (03) 6250 9200 or email tasman@tasman.tas.gov.au during the period for which representations may be made, until 18 September 2025

Any person may make a representation relating to the application. Representations are to be made in writing addressed to the General Manager, Tasman Council, 1713 Main Road, Nubeena TAS 7184 or by email to <a href="mailto:tasman@tasman.tas.gov.au">tasman@tasman.tas.gov.au</a> and will be received no later than 18 September 2025. Late representations will not be considered.

Blake Repine General Manager

Blik Rans

Date: 03 September 2025

DA 59 / 2025 – 146 Sloping Main Dr, Sloping Main (CT: 89648/2) – The relevant plans and documents can be inspected at the Council Offices at 1713 Main Road, Nubeena during normal office hours, or the plans may be viewed on Council's website at <a href="https://www.tasman.tas.gov.au">www.tasman.tas.gov.au</a> until the date representations close 18 September 2025.

The below imagine was sourced from The List: <a href="https://maps.thelist.tas.gov.au/listmap/app/list/map">https://maps.thelist.tas.gov.au/listmap/app/list/map</a>





#### A Natural Escape

#### **Application for Planning Permit**

The personal information requested on this form is being collected by council for purpose set out in the title of the form. The personal information will be used solely by council for the primary purpose or directly related purposes. The applicant understands that personal information is provided for the above mentioned function and that he/she may apply to council for access to and/or amendment of the information. If an application is made under Section 57 of the Land Use Planning and Approvals Act 1993, a copy of the lodgement documents must be made available for any person to inspect during public notification.

Please note that any information, reports and plans submitted with an application are treated as public documents and may be reproduced for representors, referral authorities and any other persons/bodies interested in the proposal.

Requests for access or correction should be made to Tasman Council's Customer Service Officer.

#### **APPLICANT DETAILS\***

FULL NAME	Nik Valentine - Attic Building Design Pty Ltd				
POSTAL ADDRESS	20 Webb Street, Dodges Ferry, TAS			POSTCODE	7173
PHONE (BUSINESS HOURS)	MOBILE:				
EMAIL	nik@theattic.net.au				

NOTE: All Council correspondence will be emailed to the applicant unless otherwise specified.

# OWNERS DETAILS (IF DIFFERENT TO APPLICANT DETAILS)\* ENSURE OWNER DETAILS MATCH THE CURRENT CERTIFICATE OF TITLE

FULL NAME				
POSTAL ADDRESS	-		POSTCODE	
PHONE (BUSINESS HOURS)		MOBILE		
DESCRIPTION OF PROPOSED	DEVELOPMENT*			
New Dwelling  New Shed/ Outbuilding  Subdivision  Change of Use  Commercial/ Industrial Building	Extension/ Addition  Demolition  Visitor Accommodat  Other (please specification)	ion	Retrospective A For Minor Addit	• •
Are any of the components in this E.g. Use and/or development that (If yes, please specify the relevant com	has commenced without a plann		□, <b>∑</b> ,	es No
Existing Residence - Mind Due To Owner Needing To Additional Covered Entry	Install Lift For Family N			<b>'el</b>
PRESENT USE OF LAND/ BUILDING	i(S)			
Existing Residence				

ADDRESS: 1713 Main Road, NUBEENA TAS 7184 | PHONE: (03) 6250 9200 EMAIL: <a href="mailto:tasman.tas.gov.au">tasman@tasman.tas.gov.au</a> | WEB: www.tasman.tas.gov.au

#### LOCATION OF PROPOSED DEVELOPMENT\*

ADDRESS	146 Sloping Main	146 Sloping Main Drive, Sloping Main		
CERTIFICATE OF TITLE	89648	LOT NUMBER	2	
FLOOR AREA				
Existing floor area (square met	Existing floor area (square metres): 131.99 (Lower) Proposed floor area (square metres): 131.99 (Lower)			
CAR PARKING				
Number existing	2	Number proposed	2	
		•		

SITE CONTAMINATION*				
Have any potentially contaminating uses been undertaken on this site?	Yes			
(Refer to list provided on page 5)	<b>X</b> No			
TASMANIAN HERITAGE OR ABORIGINAL HERITAGE REGISTER*				
La Maiorita de la Carta de Car	Yes			
Is this property on the Tasmanian Heritage or Aboriginal Heritage Register?	X No			
VEGETATION REMOVAL*				
Does the proposal require any vegetation removal? If yes, provide details on the site plan.	Yes			
Does the proposal require any vegetation removals if yes, provide details on the site plan.	X No			
VALUE (mandatory field)				
Value of work (inc. GST)	\$_100k			

#### **DECLARATION BY APPLICANT\***

I/ we declare that the information given is a true and accurate representation of the proposed development; and I/ we am/ are liable for the payment of Council application processing fees, even in the event of the development not proceeding; and I/ we authorise Tasman Council to provide a copy of my documents relating to this application to any person for the purpose of assessment and public consultation and agree to arrange for the permission of the copyright owner of any part of this application to be obtained.

SIGNATURE OF APPLICANT	a
NAME OF APPLICANT (PLEASE PRINT)	Nik Valentine
DATE	15-07-25

#### **DECLARATION IF APPLICANT IS NOT THE OWNER**

I hereby declare that I am the applicant for the development at the address detailed in this application for a planning permit, and that I have notified the owner/s of the land for which I am making this application, in accordance with Section 52(1a) of the Land Use Planning and Approvals Act 1993.

SIGNATURE OF APPLICANT

NAME OF APPLICANT (PLEASE PRINT)

DATE

15-07-25

NAME/S OF OWNER/S NOTIFIED

19-05-25

If the land that is the subject Minister of the Crown or the completed and signed by eit 52(1d-1g) of the Land Use Pl	General Mar her the Minis	nager of the Council ter, the General Ma	l, whichevanager of	ver is applicable, m	ust be inclu	ded her	e. This consent should be
DECLARATION	l,being responsible for the administration of land at						
		declare that I have given permission for the making of this application.					
SIGNATURE OF MINISTER GENERAL MANAGER	₹/	accial canaci have given permission for the making of this application.					
DATE							
NON-RESIDENTIAL DE Note: This section must be cor or other managed/ commercia HOURS OF BUSINESS	mpleted for a	II applications for no		ntial uses, home o	ccupations a	and dom	nestic/ residential businesses
CURRENT				PROPOSED			
Monday to Friday				Monday to Frid	ay		
Saturday				Saturday			
Sunday				Sunday			
NUMBER OF EMPLOYEES	;						
CURRENT				PROPOSED			
Total Employees		Total Employees					
Employees on Site		Employees on Site					
PLANT/ MACHINERY							
Is there any large plant or machinery that would need to be installed or used on site such as refrigeration units and generators? (If yes, please list below the type of machinery and ensure location, dimensions etc are clearly marked on your plans.)							
OUTDOOR STORAGE/ SE	ATING/ NUI	MBER OF BEDS					
Is outdoor storage propo- (If yes, please ensure that you are stored. This information	our plans show					oods	Yes
If you are proposing a night club, café or the like, what is the number of seats proposed including the capacity at any bar area?  Please ensure that the arrangements a shown on your plans. This information enables us to assess the car parking arrangements.					ans. This information		
If you are proposing a hotel, motel, visitor  accommodation, hostel or the like, what is the number of beds proposed?  Please ensure the beds are clearly indicate on your plans. This information enables us assess the car parking arrangements.					is information enables us to		
GOODS DELIVERIES							
Will there be any goods of (If yes, please estimate the r				n they will make tri	ips.)		□ Yes □ No
Type and Size of Vehicle				Number of Veh	icles on		<u> </u>

Form No. 13 – Application for Planning Permit Created: 10/10/06 Updated: 26 June 2024 Printed: 1/07/24

Trip Frequency per

Month

PLANNING PERMIT – APPLICATION CHECKLIST
To ensure that we can process you application as quickly as possible, please read the following checklist carefully to ensure that you have provided the following at the time of lodging the application. If you are unclear on any aspect of your application, please phone <b>(03) 6250 9200</b> to discuss or arrange an appointment concerning your proposal. Note that, in accordance with Section 54 of the <i>Land Use Planning and Approvals Act 1993</i> , Council may require additional information.
Please complete the below checklist
Completed Application Form
<ul> <li>All sections and filled out correctly and owner details match those listed on the title documents</li> <li>Application form includes a detailed cost estimate of the proposal</li> </ul>
Written Submission
- Description of the proposed development
- Justification addressing the Performance Criteria (if applicable)
Title Documents
<ul> <li>Current copy of the Certificate of Title (Folio Plan and Text Page)</li> <li>Copies of any restrictive covenants, easements, or other relevant documents.</li> </ul>
Site Plan
- Drawn to scale
<ul> <li>Shows the location of the proposed development</li> <li>Includes existing structures, property boundaries, access points and any natural features (vegetation and</li> </ul>
waterways)
Floor Plan and Elevations
- Detailed floor plans of the proposed development
- Elevations showing the height and external appearance
Stormwater and Servicing Plan
- Details on how stormwater will be managed on-site
- Information about connections to utilities (water, sewer, electricity)
- Elevations showing the height and external appearance
Landscaping Plan (if applicable)
- Details of existing vegetation to be retained or removed
Supporting Reports and Assessments (if applicable)
- Bushfire Hazard Management Plan and Report
- Traffic Impact Assessment
- Natural Values Assessment
- Onsite Wastewater Assessment
Dated: 15-07-25
Signed:
Please note that application fees will be invoiced upon initial assessment.  Planning application assessment fees excluding subdivision assessment:
i willing application assessment ices excluding subulvision assessment.

POTENTIALLY CONTAMINATING ACTIVITIES				
Agricultural Fertiliser Manufacture	Metal Founders			
Asbestos Production and Manufacture	Metal Sprayers			
Battery Manufacture and Recycling	Metal Treatments and Picklers			
Chemical Manufacture or Formation	Mining and Extractive Industries			
Defence Establishments and Training Areas	Pest Controllers (being areas where pest control chemicals are stored or vehicles and tanks used in connection with pest control are washed.)			
Drum Reconditioning Wastes	Petroleum and Petrochemical Industries			
Dry Cleaning Establishments	Pharmaceutical Manufacture or Formation			
Electroplating	Printers			
Explosives Production and Storage	Railway Yards			
Fuel Depots and Storage Areas	Sanitary and Refining			
Galvanisers	Scrap Yards			
Gas Works	Service Stations			
Gun, Pistol and Rifle Clubs	Smelting and Refining			
Hazardous Waste Landfills	Tannery or Fellmongery or Hide Curing Works			
Industrial Cleaners	Wood Treatment and Preservation Sites			
Lime Burners				



#### **RESULT OF SEARCH**

**RECORDER OF TITLES** 





#### SEARCH OF TORRENS TITLE

VOLUME	FOLIO
89648	2
EDITION	DATE OF ISSUE
2	14-Apr-2003

SEARCH DATE : 14-Jul-2025 SEARCH TIME : 02.58 PM

#### DESCRIPTION OF LAND

Parish of TOGANEE, Land District of PEMBROKE Lot 2 on Plan 89648 (formerly being P1591(B)) Derivation: Part of Lot 6995 Gtd to Prior CT 2117/11

#### SCHEDULE 1

C437682 TRANSFER to Registered 14-Apr-2003 at noon

#### SCHEDULE 2

Reservations and conditions in the Crown Grant if any A225445 EASEMENTS set forth in Order A225445 FENCING COVENANT set forth in Order

#### UNREGISTERED DEALINGS AND NOTATIONS

No unregistered dealings or other notations




#### **FOLIO PLAN**

RECORDER OF TITLES



Issued Pursuant to the Land Titles Act 1980

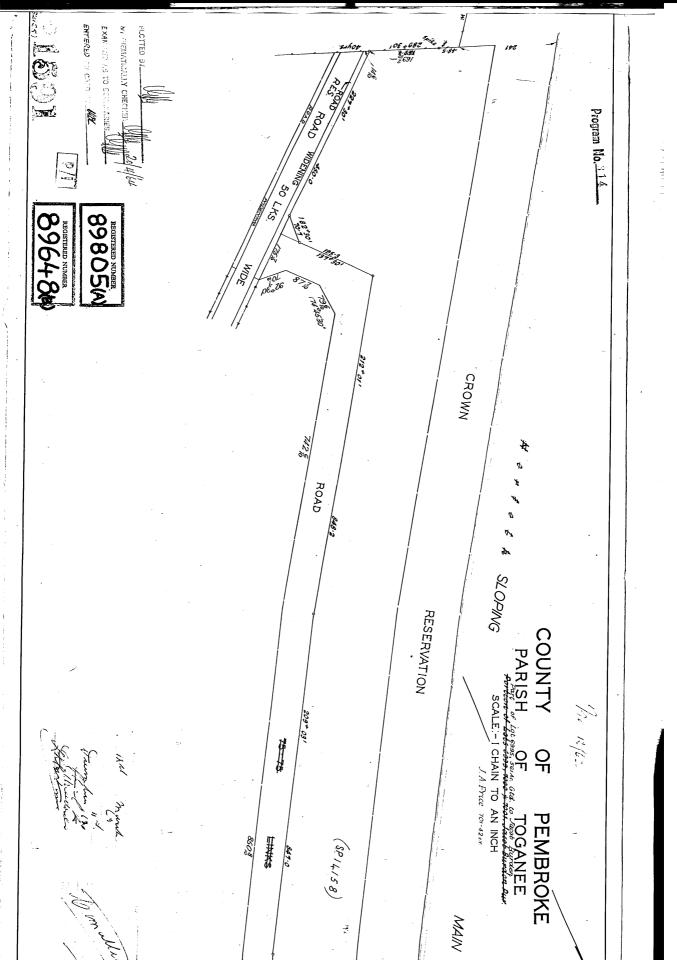

Search Date: 14 Jul 2025

Search Time: 02:58 PM

Volume Number: 89648

Revision Number: 01

Page 1 of 2




### **FOLIO PLAN**

RECORDER OF TITLES



Issued Pursuant to the Land Titles Act 1980

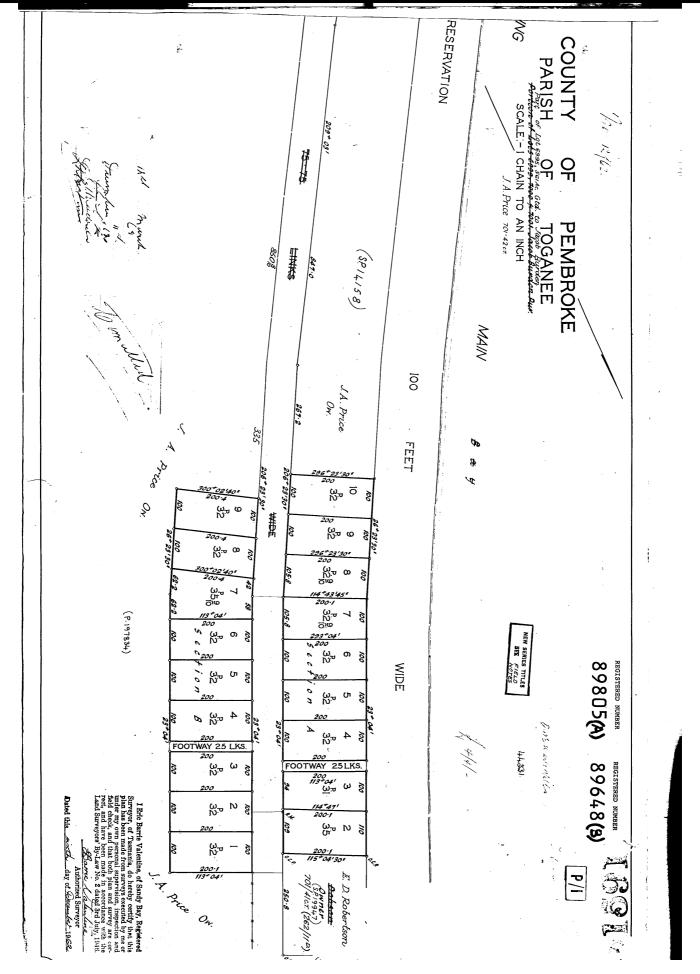

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#### PROPOSED RETROSPECTIVE APPROVAL FOR: **DAVIES**

146 SLOPING MAIN DRIVE, SLOPING MAIN TAS 7186

LOT NO: TBC VOLUME: TBC FOLIO: TBC

WIND CLASS: N3/4 CLIMATE ZONE: 7 BUILDING CLASS: TBC SITE AREA: TBC m<sup>2</sup>

BAL: **N/A** ALPINE AREA: **N/A BCA FIGURE 3.7.5.2** 

SOIL CLASS: TBC

CORROSION ENVIRONMENT: N/A - FOR STEEL SUBJECT TO THE INFLUENCE OF SALT WATER, BREAKING SURF OR HEAVY INDUSTRIAL AREAS, REFER TO BCA SECTION 3.4.2.2 & BCA TABLE 3.4.4.2 CLADDING AND FIXINGS TO MANUFACTURER'S RECOMMENDATIONS

OTHER HAZARDS: N/A - HIGH WIND, EARTHQUAKE, FLOODING, LANDSLIP, DISPERSIVE SOILS, SAND DUNES, MINE SUBSIDENCE, LANDFILL, SNOW & ICE OR OTHER RELEVANT FACTORS

## **BAL - 12.5 REQUIRED BUSHFIRE CONSTRUCTION LEVEL**

#### STAGE 1

- 1 COVER PAGE
- 2 PLANNING SCHEME ASSESSMENT
- 3 EXISTING LOCATION PLAN LG
- 4 EXISTING LOCATION PLAN L1 5 EXISTING / DEMOLITION PLAN LG
- 6 EXISTING / DEMOLITION PLAN L1
- 7 PROPOSED LOCATION PLAN LG 8 PROPOSED FLOOR PLAN LG
- 9 PROPOSED FLOOR PLAN L1

#### STAGE 2

- 10 EXISTING ELEVATIONS 1
- 11 EXISTING ELEVATIONS 2

**DAVIES** 


NEW RETROSPECTIVE APPROVAL 146 SLOPING MAIN DRIVE, **SLOPING MAIN, TAS 7186** 

DATE: 28/8/2025 SIZE: A2 SCALE: JOB: #ATT1671 DRAWN: N VALENTINE EMAIL: NIK@THEATTIC.NET.AU

# LOW DENSITY RESIDENTIAL ZONE TASMANIAN PLANNING SCHEME

SCHEME   PRO	ROVISION	ACCEPTABLE SOLUTION	PERFORMANCE CRITERIA	COMPLIANCE	DEVELOPMENT RESPONSE
10.4.3 Sett	tback	A1 Dwellings, excluding protrusions that extend not more than 0.9m into the frontage setback, must have a setback from a frontage not less than 8m.	P1 The siting of a dwelling must be compatible with the streetscape and character of development existing on established properties in the area, having regard to:  (a) the topography of the site;  (b) the setbacks of surrounding buildings;  (c) the height, bulk and form of existing and proposed buildings;  (d) the appearance when viewed from roads and public open space adjacent to the site; and  (e) the safety of road users.	PERFORMANCE ASSESSMENT APPLIED	<ul> <li>(a) The proposed new water tank, which is required to be sited closer to the front fence for firefighting access, will not impede on any use of the adjacent sites, whilst also having regard to the potential BHMP and BAL requirements. The topography of the site is relatively flat and hence this should reduce any dominance from the proposed waster tank location.</li> <li>(b) Given the high prevalence of structures built on the front boundary, either with carports or sheds, all along this road, we do not feel that the presence of a water tank will be out of character when comparing this to surrounding buildings.</li> <li>(c) The proposed water tank is relatively low in height and is unlikely to dominate the streetscape, when compared to other structures adjacent to this site, such as carports and sheds.</li> <li>(d) The appearance of the proposed tank is smaller than that of surrounding structures which are also located on the front boundary.</li> <li>This being said, we have attempted to locate the tank in the corner of the property, near the fence, to ensure that this does not detract away from any adjacent buildings.</li> <li>(e) The safety of road users will not be altered by the location of this new tank.</li> <li>In addition to the above, it's also worth noting that by locating the water tank close to the front fence, this will avoid the need for our clients to pave the entirety of their front yard, for firefighting road access.</li> </ul>
		A2 Dwellings, excluding outbuildings with a building height of not more than 2.4m and protrusions that extend not more than 0.9m horizontally from the building, must have a setback from side and rear boundaries of not less than 5m.	The siting of a dwelling must not cause an unreasonable loss of amenity to adjoining properties, having regard to:  (a) the topography of the site;  (b) the size, shape and orientation of the site;  (c) the setbacks of surrounding buildings;  (d) the height, bulk and form of existing and proposed buildings;  (e) the existing buildings and private open space areas on the site;  (f) sunlight to private open space and windows of habitable rooms on adjoining properties; and  (g) the character of development existing on established properties in the area.	PERFORMANCE ASSESSMENT APPLIED	The proposed new water tank has been placed closer to the side setback to ensure that this is not visible to the neighbours (from their living areas) nor the occupants of the site address. We feel that this provides a better outcome aesthetically, rather than this being placed in the middle of the front yard, which would be required if we were to comply with the relevant setbacks.  (a) The topography of the site is relatively flat and hence this should reduce any dominance from the proposed waster tank location.  (b) The size and shape and orientation of the site will not be impeded in any way by the proposed water tank.  (c) As noted above, given the high prevalence of structures built on the side boundaries within the immediate area, we do not feel that the presence of a water tank will be out of character when comparing this to surrounding buildings / sites.  (d) As also noted above, the appearance of the proposed tank is smaller than that of surrounding structures which are also located on the side boundaries, so we believe that the height and bulk of this new tank will be less than that of nearby developments with similar setbacks.  (e) The proposed siting will allow the owners to better utilise their front yard (and private open space).  (f) The proposed siting will allow the owners to receive more sunlight into their front windows, in comparison to the reduction that would occur if the new tank was to comply with these setbacks.  Furthermore, we do not believe that the proposed new tank will significantly impact the adjoining properties private open space or habitable rooms.  (g) As we touched on above, given the high prevalence of structures built on the side boundaries within the immediate area, we do not feel that the presence of a water tank will be out of character when comparing this to surrounding buildings / sites.


**SLOPING MAIN DRIVE** 

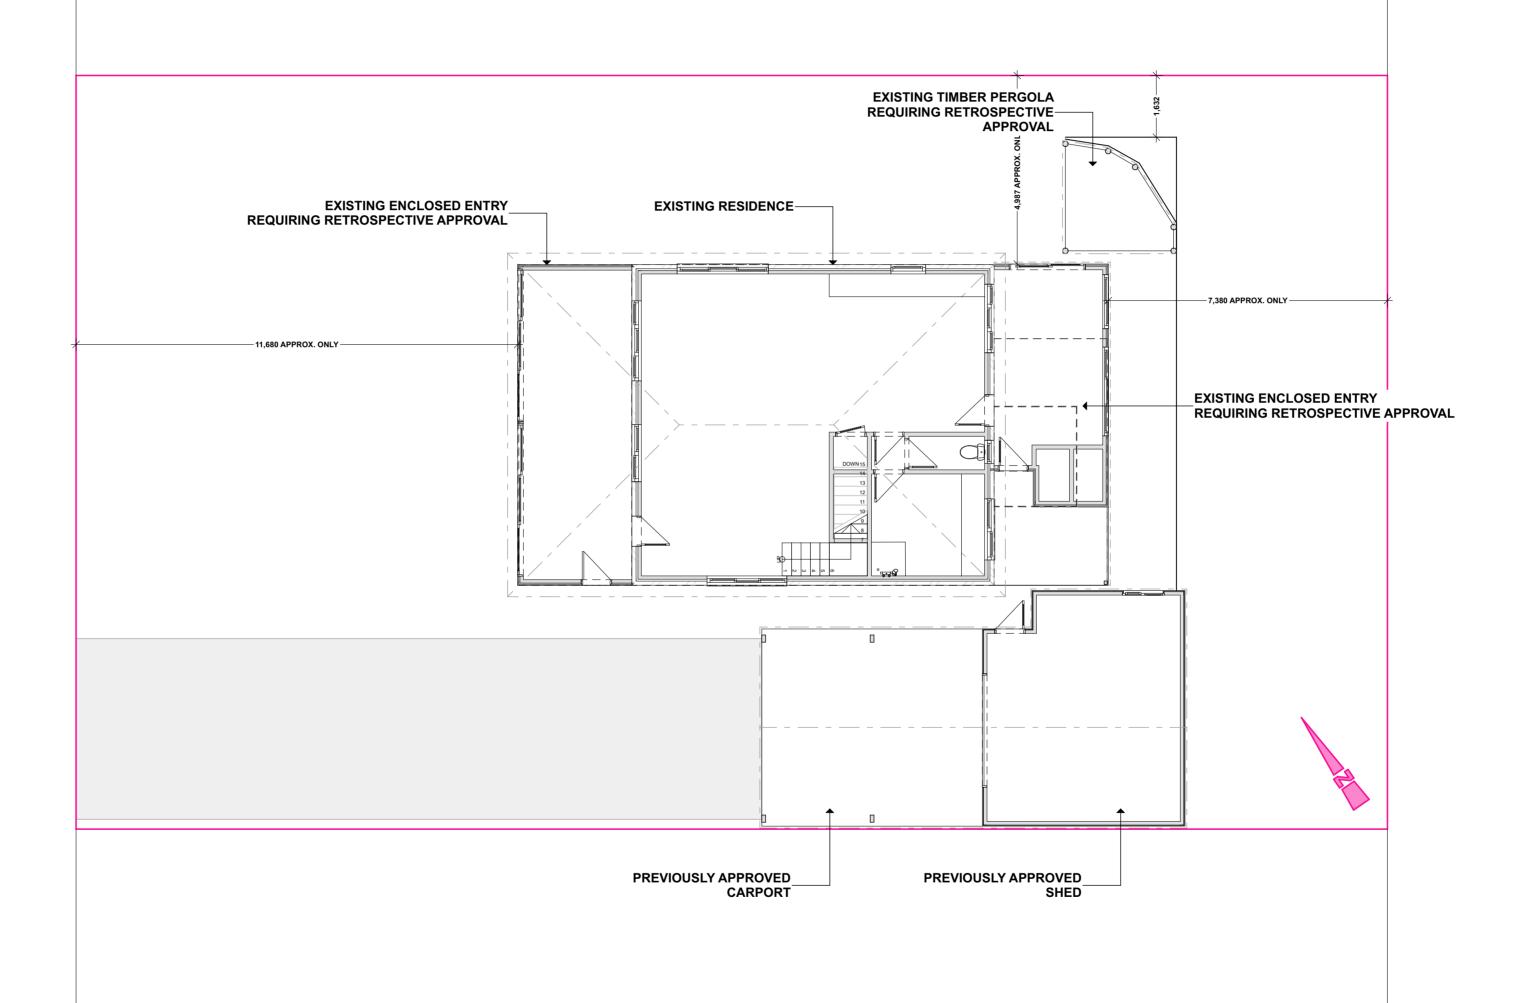

NEW RETROSPECTIVE APPROVAL

146 SLOPING MAIN DRIVE, **SLOPING MAIN, TAS 7186** DATE: 28/8/2025 SIZE: A2 SCALE:1:100 JOB: #ATT1671 DRAWN: N VALENTINE EMAIL: NIK@THEATTIC.NET.AU

**DAVIES** 

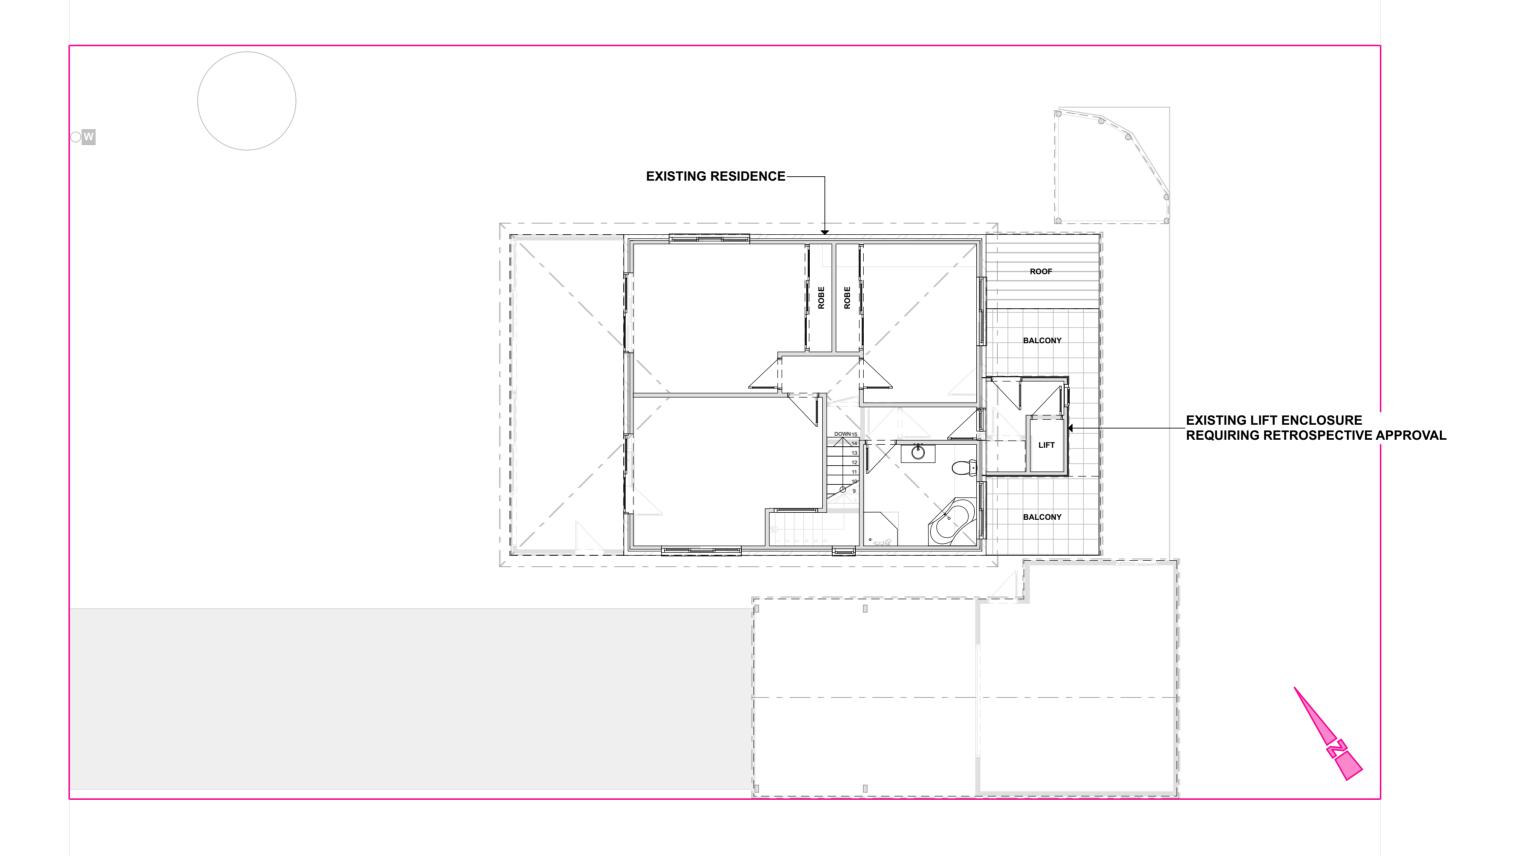

# **DAVIES**

NEW RETROSPECTIVE APPROVAL 146 SLOPING MAIN DRIVE, **SLOPING MAIN, TAS 7186** DATE: 28/8/2025 SIZE: A2 SCALE:1:100

JOB: #ATT1671 DRAWN: N VALENTINE EMAIL: NIK@THEATTIC.NET.AU



IMPORTANT:
BUILDER TO VERIFY ALL EXISTING AND PROPOSED DIMENSIONS ON SITE, BOTH PRIOR TO & DURING CONSTRUCTION W00 WINDOW ID D00 DOOR ID ALL PROPOSED SHOWER(S) TO BE ENCLOSED U.N.O TIMBER PERGOLA 6.36 m<sup>2</sup> CH: 2,075 mm **SLOPING MAIN DRIVE** -11.680 APPROX. ONLY-KITCHEN 17.18 m<sup>2</sup> CH: 2,375 mm ENCLOSED ENTRY 13.32 m<sup>2</sup> CH: 2,375 mm 23.48 m<sup>2</sup> CH: 2,375 mm LIVING | DINING - 39.64 m<sup>2</sup> CH: 2,375 mm BATH | L'DRY 8.05 m<sup>2</sup> CH: 2,375 mm

MECHANICAL VENTILATION TO BE PROVIDED IN ACCORDANCE WITH PART 3.8.5 of BCA/NCC TO AMENITY AREAS, WHERE NATURAL VENTILATION IS NOT ACHIEVABLE.

**DAVIES** 

NEW RETROSPECTIVE APPROVAL 146 SLOPING MAIN DRIVE, **SLOPING MAIN, TAS 7186** DATE: 28/8/2025 SIZE: A2 SCALE:1:100

SHED

IMPORTANT:
BUILDER TO VERIFY ALL EXISTING AND PROPOSED DIMENSIONS ON SITE, BOTH PRIOR TO & DURING CONSTRUCTION

SLOPING MAIN DRIVE

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W00 WINDOW ID

D00 DOOR ID

ALL PROPOSED SHOWER(S) TO BE ENCLOSED U.N.O

**BED 2** 19.17 m<sup>2</sup> CH: 2,410 mm BED 3 14.64 m<sup>2</sup> 7 CH: 2,410 mm BALCONY \_\_New Stainless Steel Screen Door To BAL 12.5 Construction Requirement COVERED BALCONY 25.36 m<sup>2</sup> CH; 2,410 mm BED 1 | MASTER 18.17 m<sup>2</sup> CH: 2,410 mm 8.03 m<sup>2</sup> CH: 2,410 mm BALCONY \_Bulkhead At 2131mm High

MECHANICAL VENTILATION TO BE PROVIDED IN ACCORDANCE WITH PART 3.8.5 of BCA/NCC TO AMENITY AREAS, WHERE NATURAL VENTILATION IS NOT ACHIEVABLE.

**DAVIES** 

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EMAIL: NIK@THEATTIC.NET.AU

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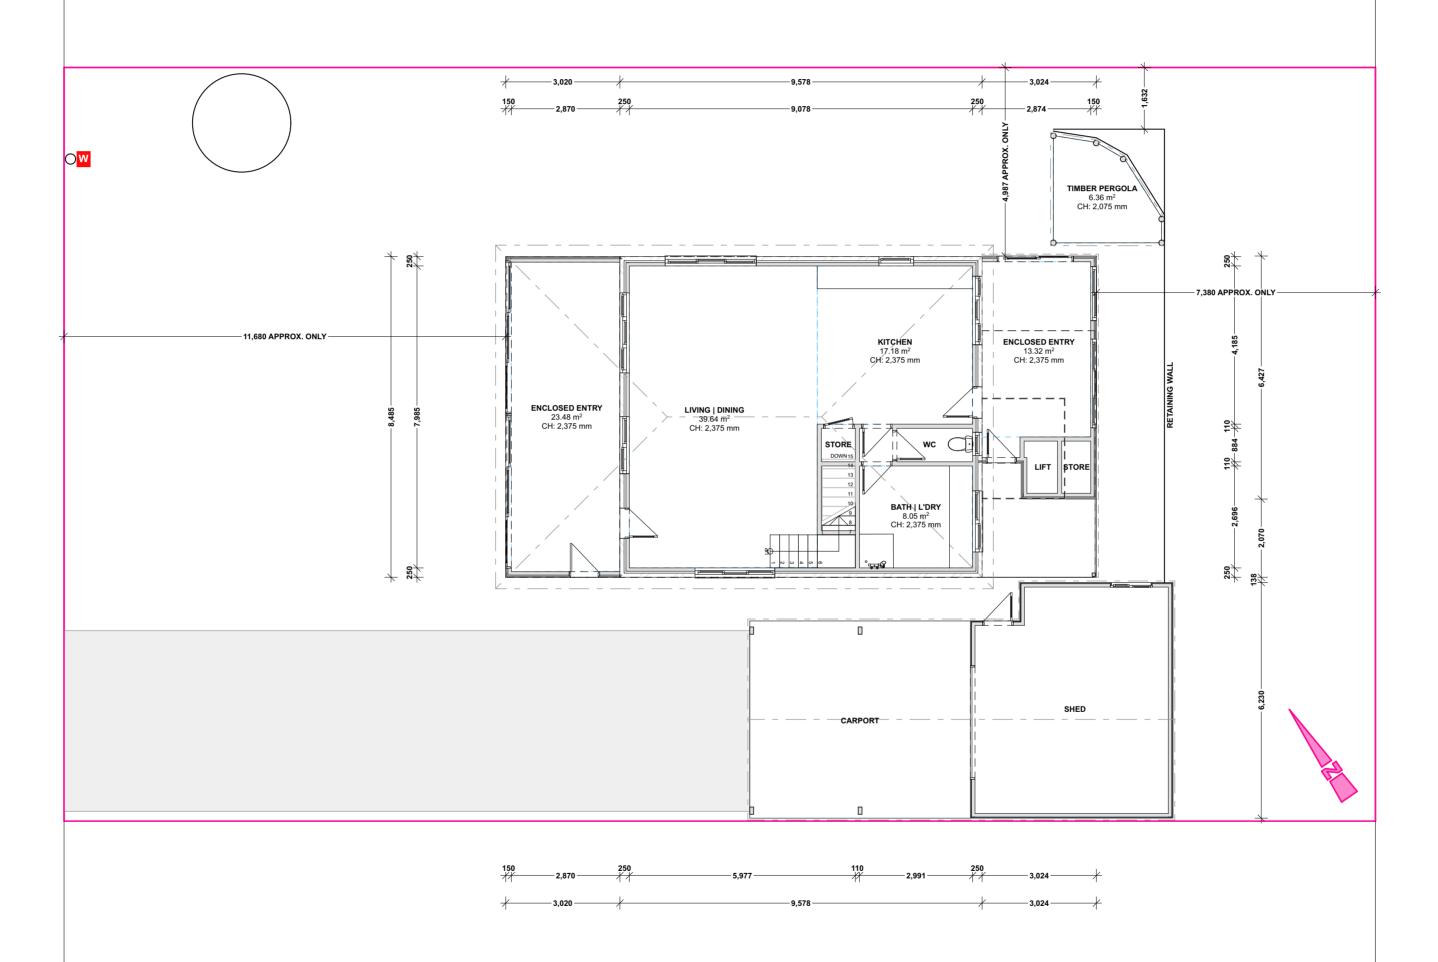
W00 WINDOW ID

D00 DOOR ID

ALL PROPOSED SHOWER(S) TO BE ENCLOSED U.N.O

**SLOPING MAIN DRIVE** 

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MECHANICAL VENTILATION TO BE PROVIDED IN ACCORDANCE WITH PART 3.8.5 of BCA/NCC TO AMENITY AREAS, WHERE NATURAL VENTILATION IS NOT ACHIEVABLE.

**DAVIES** 

NEW RETROSPECTIVE APPROVAL 146 SLOPING MAIN DRIVE, **SLOPING MAIN, TAS 7186**  SLOPING MAIN DRIVE

W

D00 DOOR ID

ALL PROPOSED SHOWER(S) TO BE ENCLOSED U.N.O

**BED 2** 19.17 m<sup>2</sup> CH: 2,410 mm BED 3 14.64 m<sup>2</sup> CH: 2,410 mm BALCONY COVERED BALCONY 25.36 m<sup>2</sup> CH: 2,410 mm BED 1 | MASTER 18.17 m<sup>2</sup> CH: 2,410 mm **BATH** 8.03 m<sup>2</sup> CH: 2,410 mm BALCONY \_Bulkhead At 2131mm High 2,179 \_\_\_\_\_\_ 810 \_\_\_\_

\_New Stainless Steel Screen Door To BAL 12.5 Construction Requirements

110

MECHANICAL VENTILATION TO BE PROVIDED IN ACCORDANCE WITH PART 3.8.5 of BCA/NCC TO AMENITY AREAS, WHERE NATURAL VENTILATION IS NOT ACHIEVABLE.

**DAVIES** 

NEW RETROSPECTIVE APPROVAL 146 SLOPING MAIN DRIVE, **SLOPING MAIN, TAS 7186** DATE: 28/8/2025 SIZE: A2 SCALE:1:100



OPERABLE WINDOWS & DOORS MAY BE SHOWN IN THEIR OPEN STATE, FOR ILLUSTRATIVE PURPOSES ONLY

LIFT OF HINGES TO WATER CLOSETS LOCATED WITHIN 1.2M OF THE DOORWAY SWING \* DECALS : MIN. 20mm HIGH DECALS TO FULL HEIGHT GLAZING LOCATED BETWEEN 700MI AND 1200MM HIGH FROM FINISHED FLOOR LEVEL \* REFER TO APPROVED ENERGY REPORT FOR GLAZING U-VALUES & SHGC \* REFER TO ELEVATIONS FOR SPECIFICATION OF OBCURE GLAZING

# Existing Roof Cladding - Colorbond Custom Orb - Colour: Green — Approx. 25.00° Pitch (To Be Confirmed) 131.99 SQM Existing Roof Cladding - Colorbond Long-Line - Colour: Surfmist — Approx. 10.00° Pitch (To Be Confirmed) 65.15 SQM L1 FFL 18.92 18.67 Existing Wall Cladding - Horizontal Colorbond Cladding - Surfmist 21.94 sqm

#### NORTH WEST | ELEVATION



**SOUTH WEST | ELEVATION** 

MPORTANT: ALL WINDOWS LOCATED 2.0m ABOVE THE SURFACE BENEATH ARE TO BE PROVIDED WITH WINDOW RESTRICTORS TO REFLECT A MAXIMUM OPENING OF 124mm, TO RESIST AN OUTWARD HORIZONTAL ACTION OF 250N IN ACCORDANCE WITH NCC PART 3.9.2.5

HERE THE RESTRICTING DEVICE OR SCREEN CAN BE REMOVED, UNLOCKED OR OVERRIDDEN, A PERMANENT BARRIER WITH A EIGHT NOT LESS THAN 865m ABOVE THE FLOOR IS REQUIRED TO THE OPENABLE WINDOW, IN ADDITION TO WINDOW ROTECTION. THE BARRIER MUST NOT HAVE ANY HORIZONTAL OR NEAR HORIZONTAL ELEMENTS BETWEEN 150mm AND 760mm

GRADE 'A' SAFETY GLAZING IS REQUIRED TO ALL WINDOWS WITHIN 500mm OFF THE FLOOR, WITHIN 300mm OF A DOOR, WITHIN 2000mm OFF THE FLOOR IN ALL WET AREAS AND IS SUSCEPTIBLE TO HUMAN IMPACT.

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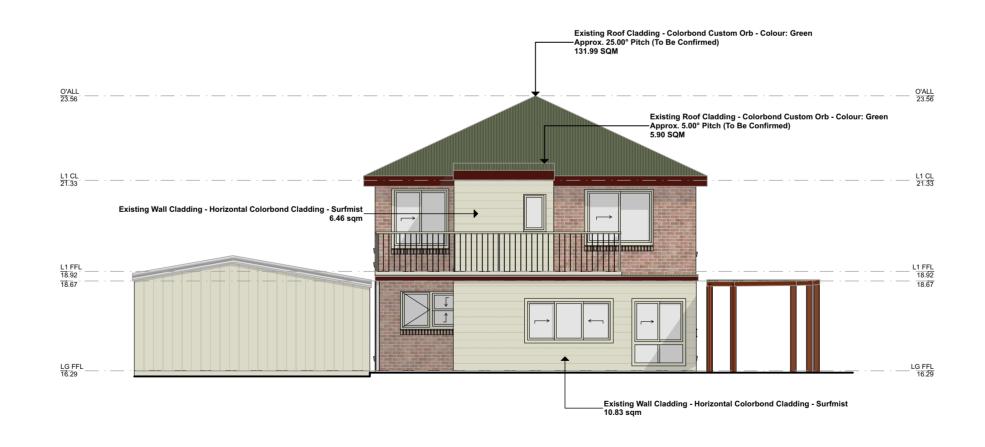
**DAVIES** 

NEW RETROSPECTIVE APPROVAL 146 SLOPING MAIN DRIVE, **SLOPING MAIN, TAS 7186** DATE: 28/8/2025 SIZE: A2 SCALE:1:100 OPERABLE WINDOWS & DOORS MAY BE SHOWN IN THEIR OPEN STATE, FOR ILLUSTRATIVE PURPOSES ONLY

MPORTANT: ALL WINDOWS LOCATED 2.0m ABOVE THE SURFACE BENEATH ARE TO BE PROVIDED WITH WINDOW RESTRICTORS TO REFLECT A MAXIMUM OPENING OF 124mm, TO RESIST AN OUTWARD HORIZONTAL ACTION OF 250N IN ACCORDANCE WITH NCC PART 3.9.2.5 LIFT OF HINGES TO WATER CLOSETS LOCATED WITHIN 1.2M OF THE DOORWAY SWING WHERE THE RESTRICTING DEVICE OR SCREEN CAN BE REMOVED, UNLOCKED OR OVERRIDDEN, A PERMANENT BARRIER WITH A HEIGHT NOT LESS THAN 865m ABOVE THE FLOOR IS REQUIRED TO THE OPENABLE WINDOW, IN ADDITION TO WINDOW PROTECTION. THE BARRIER MUST NOT HAVE ANY HORIZONTAL OR NEAR HORIZONTAL ELEMENTS BETWEEN 150mm AND 760mm ABOVE THE FLOOR THAT FACILITATE CLIMBING. \* DECALS : MIN. 20mm HIGH DECALS TO FULL HEIGHT GLAZING LOCATED BETWEEN 700MI AND 1200MM HIGH FROM FINISHED FLOOR LEVEL REFER TO APPROVED ENERGY REPORT FOR GLAZING U-VALUES & SHGC GRADE 'A' SAFETY GLAZING IS REQUIRED TO ALL WINDOWS WITHIN 500mm OFF THE FLOOR, WITHIN 300mm OF A DOOR, WITHIN 2000mm OFF THE FLOOR IN ALL WET AREAS AND IS SUSCEPTIBLE TO HUMAN IMPACT. \* REFER TO ELEVATIONS FOR SPECIFICATION OF OBCURE GLAZING



#### NORTH EAST | ELEVATION



#### **SOUTH EAST | ELEVATION**

**DAVIES** 

NEW RETROSPECTIVE APPROVAL 146 SLOPING MAIN DRIVE, **SLOPING MAIN, TAS 7186** DATE: 28/8/2025 SIZE: A2 SCALE:1:100 JOB: #ATT1671 DRAWN: N VALENTINE

